



# UTAH NATIONAL GUARD

## LOGAN ARMORY UNHEATED STORAGE BUILDING DESIGN DFCM PROJECT NO. 05191480 CONTRACT NO.

ARCHITECT'S PROJECT NUMBER: B05-044

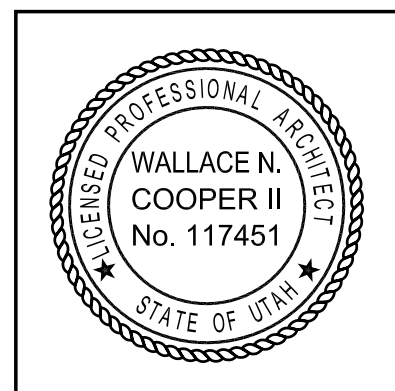

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### SHEET INDEX

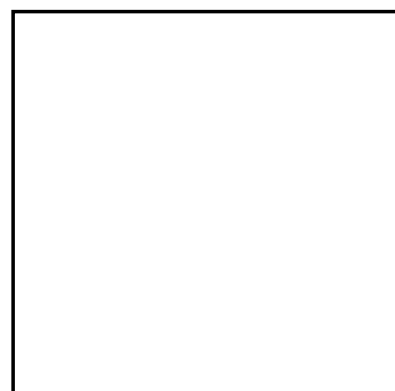SHEET	DESCRIPTION
General	
GI001	COVER SHEET & SHEET INDEX
Architectural	
AS101	ARCHITECTURAL SITE PLAN
AE101	PLANS AND DETAILS
Electrical	
EG001	SYMBOLS, SCHEDULES, NOTES & FLOOR PLANS
ES101	ELECTRICAL SITE PLAN
EE101	(NOT USED)
EX101	ONE-LINE DIAGRAM & PANELBOARD SCHEDULE

C O O P E R  
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S I M O N S E N  
A R C H I T E C T U R E



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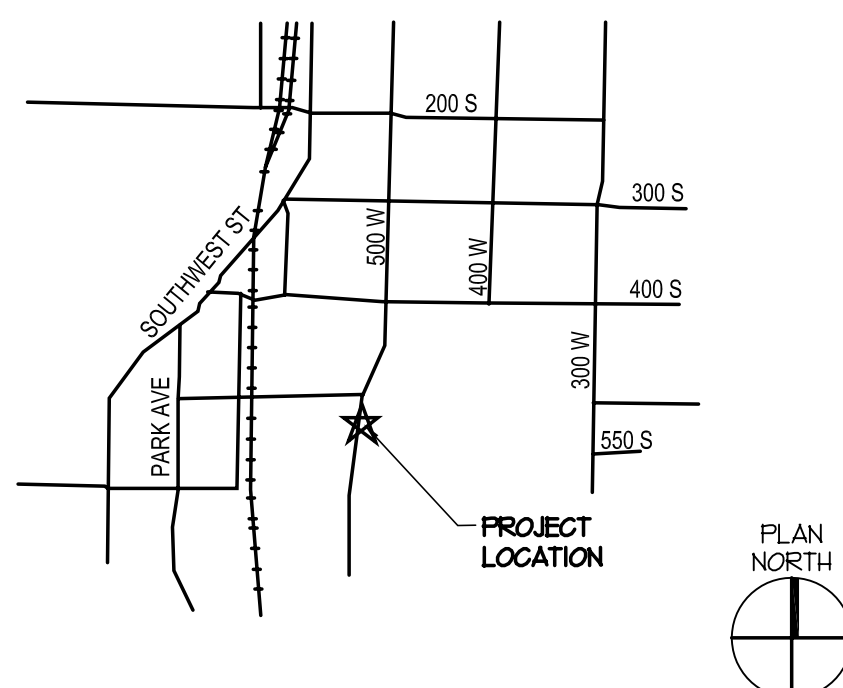
UTNG LOGAN ARMORY  
UNHEATED STRG. BLDG.  
DFCM PROJ. NO. 05191480  
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LOGAN, UTAH

UTAH NATIONAL GUARD  
12953 SOUTH MINUTEMAN DRIVE  
DRAPER, UTAH 84020-1776

### SYMBOLS LEGEND

DETAIL NUMBER SHEET NUMBER	C5 AE502	DETAIL REFERENCE	1	REFERENCE NOTE	CONCRETE
	A1 AE202	EXTERIOR ELEVATION REFERENCE	A	WALL TYPE	CONCRETE BLOCK
	A4 AE301	SECTION REFERENCE	W1	FINISH TYPE	MASONRY
	B2 AE401	INTERIOR ELEVATION REFERENCE (SINGLE)	A	WINDOW TYPE	STEEL
DETAIL NUMBER	B2 AE401	INTERIOR ELEVATION REFERENCE (MULTIPLE)	NAME 101	ROOM NOTE	BATT INSULATION
B3 B4			DOOR # FRAME TYPE	DOOR NOTE DOOR TYPE	RIGID INSULATION
			FINISH CEILING HEIGHT	CEILING TYPE	FINISH GRADE WOOD
			A	FURNITURE NOTE	PLYWOOD
			1	REVISION NOTE	DEMOLITION
				ELEVATION MARKER	

### VICINITY MAP



### CLIENT APPROVAL

THE UNDERSIGNED HAS REVIEWED THESE PLANS AND SPECIFICATIONS AND FINDS  
THEM ACCEPTABLE. CHANGES IN THE PORTION OF THE PLANS HEREIN APPROVED MAY  
RESULT IN A CHANGE IN THE COST OF THE PROJECT.

CONSTRUCTION DOCUMENTS

PHASE

7/22/05

DATE

DFCM

DATE

UTAH NATIONAL GUARD

DATE

COVER SHEET &  
SHEET INDEX

**GI001**  
SHEET 1 OF 4

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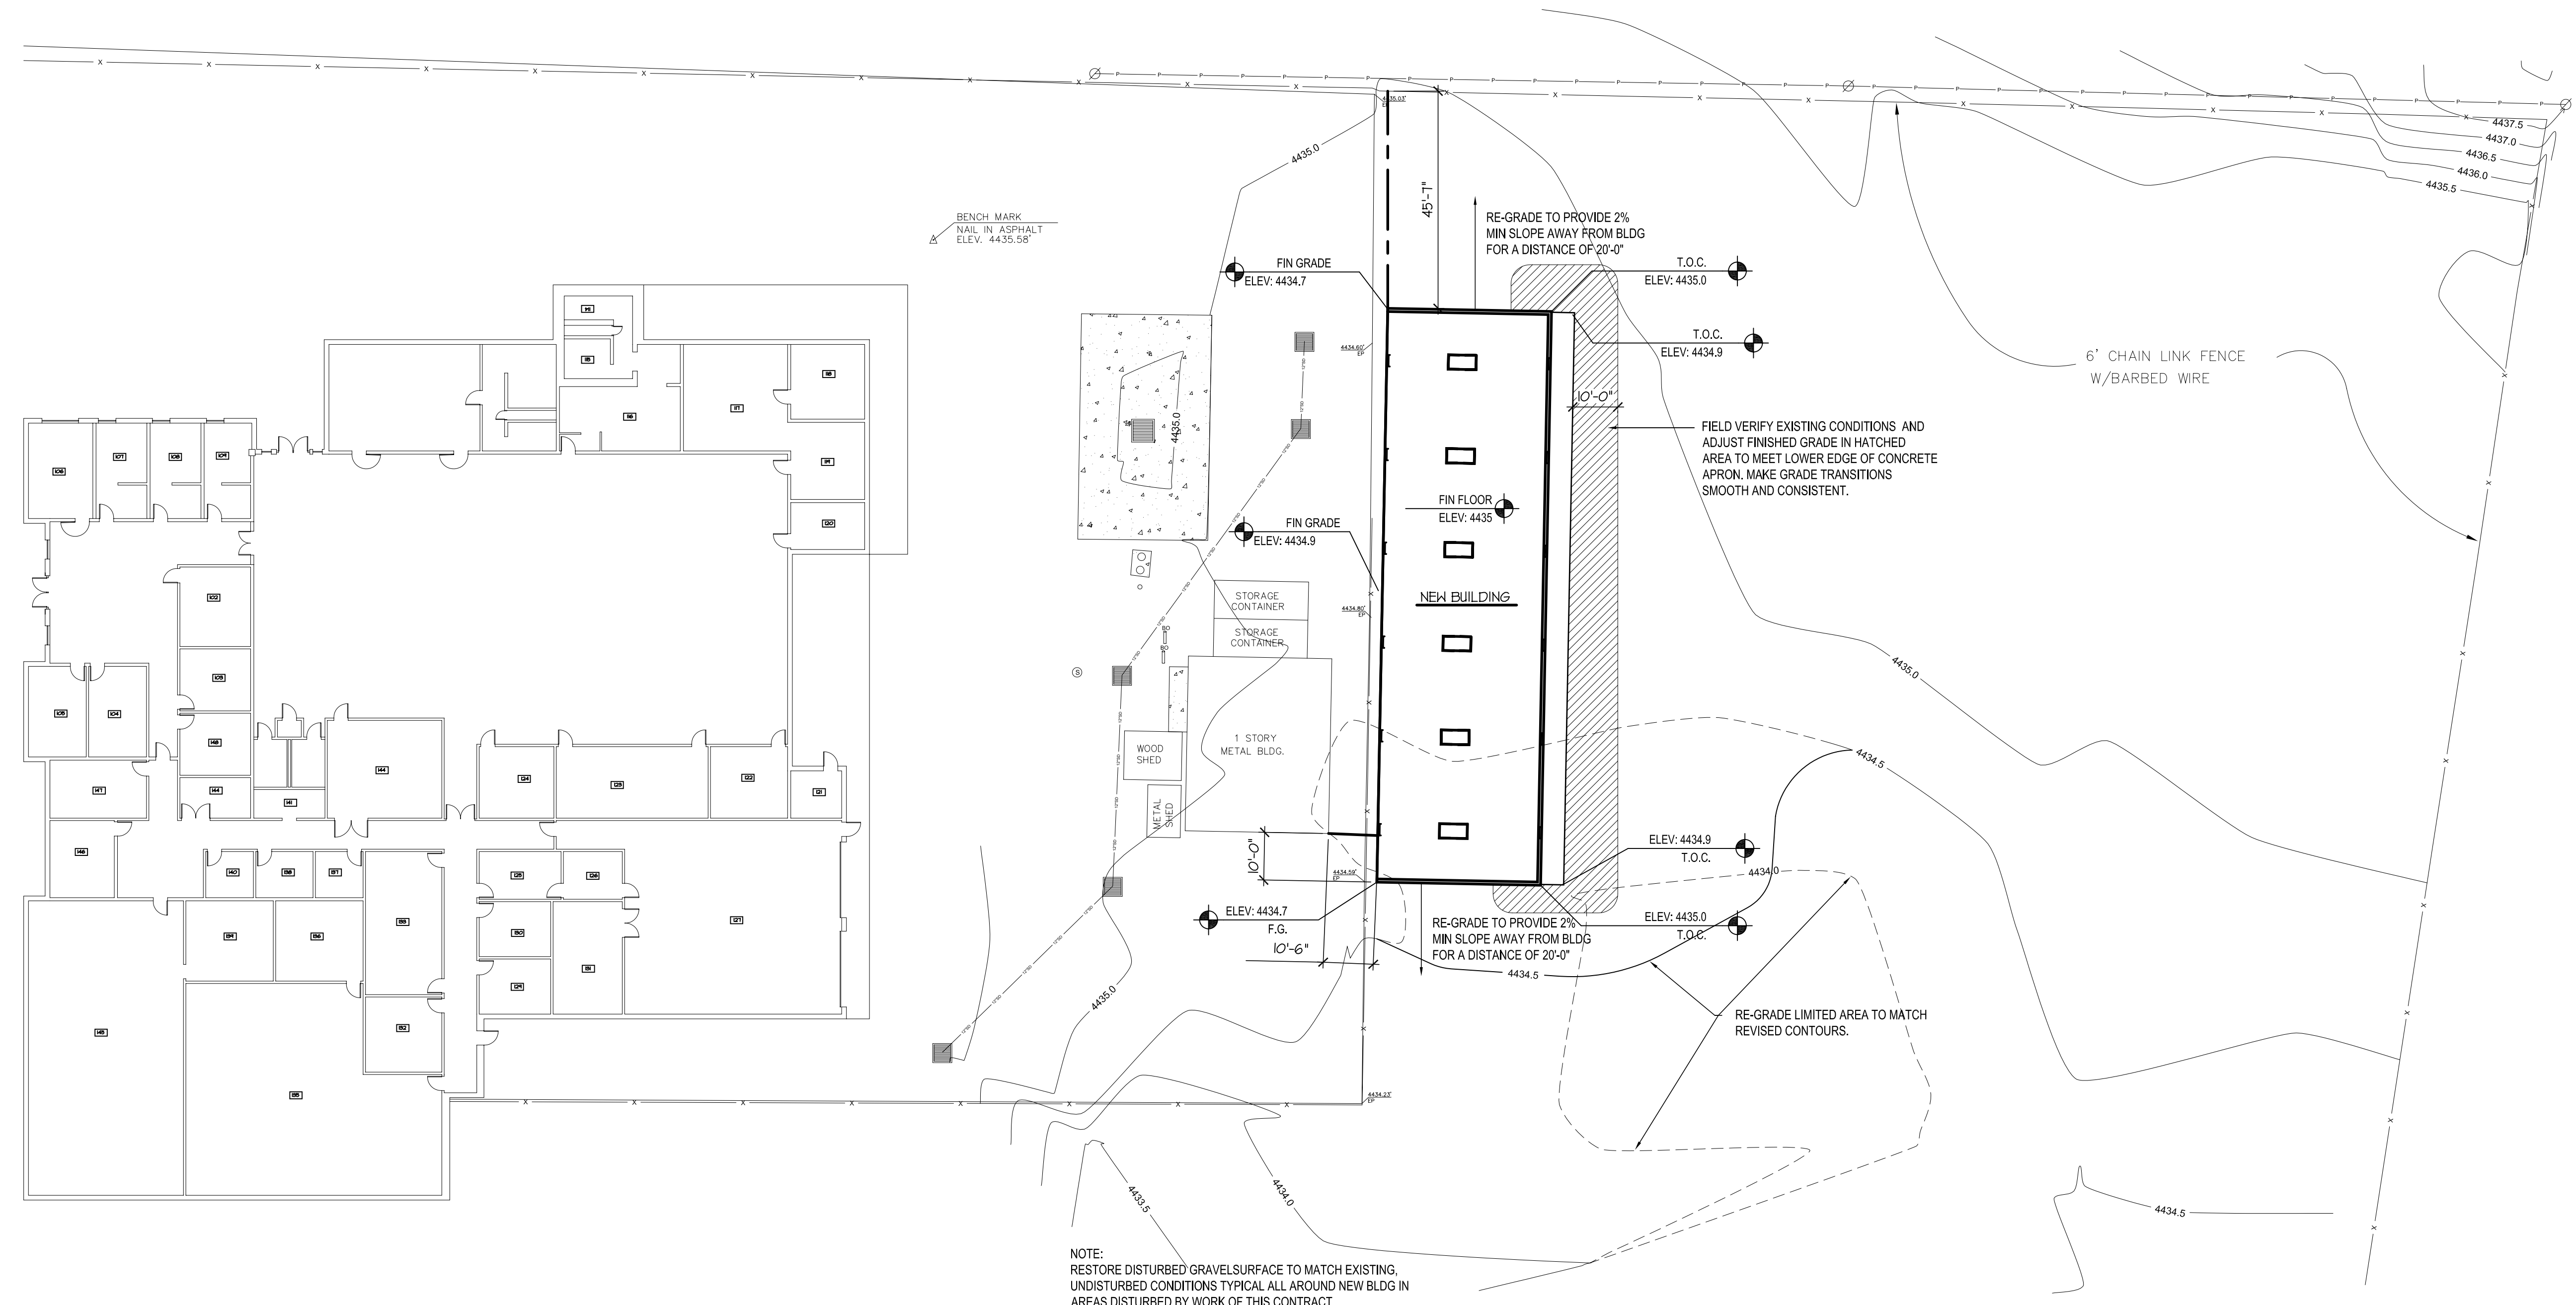
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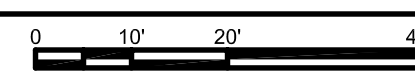
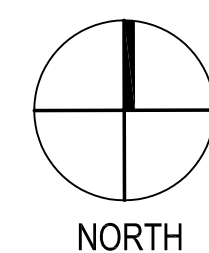
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PROJECT NO: B05-044		
CAD DWG FILE: AS101.dwg		
DRAWN BY: SJF		
CHECKED BY: BB		

ARCHITECTURAL  
SITE PLAN


**AS101**  
SHEET 2 OF 4



NOTE:  
RESTORE DISTURBED GRAVEL SURFACE TO MATCH EXISTING,  
UNDISTURBED CONDITIONS TYPICAL ALL AROUND NEW BLDG IN  
AREAS DISTURBED BY WORK OF THIS CONTRACT.




**A1** ARCHITECTURAL SITE PLAN  
SCALE: 1" = 20'

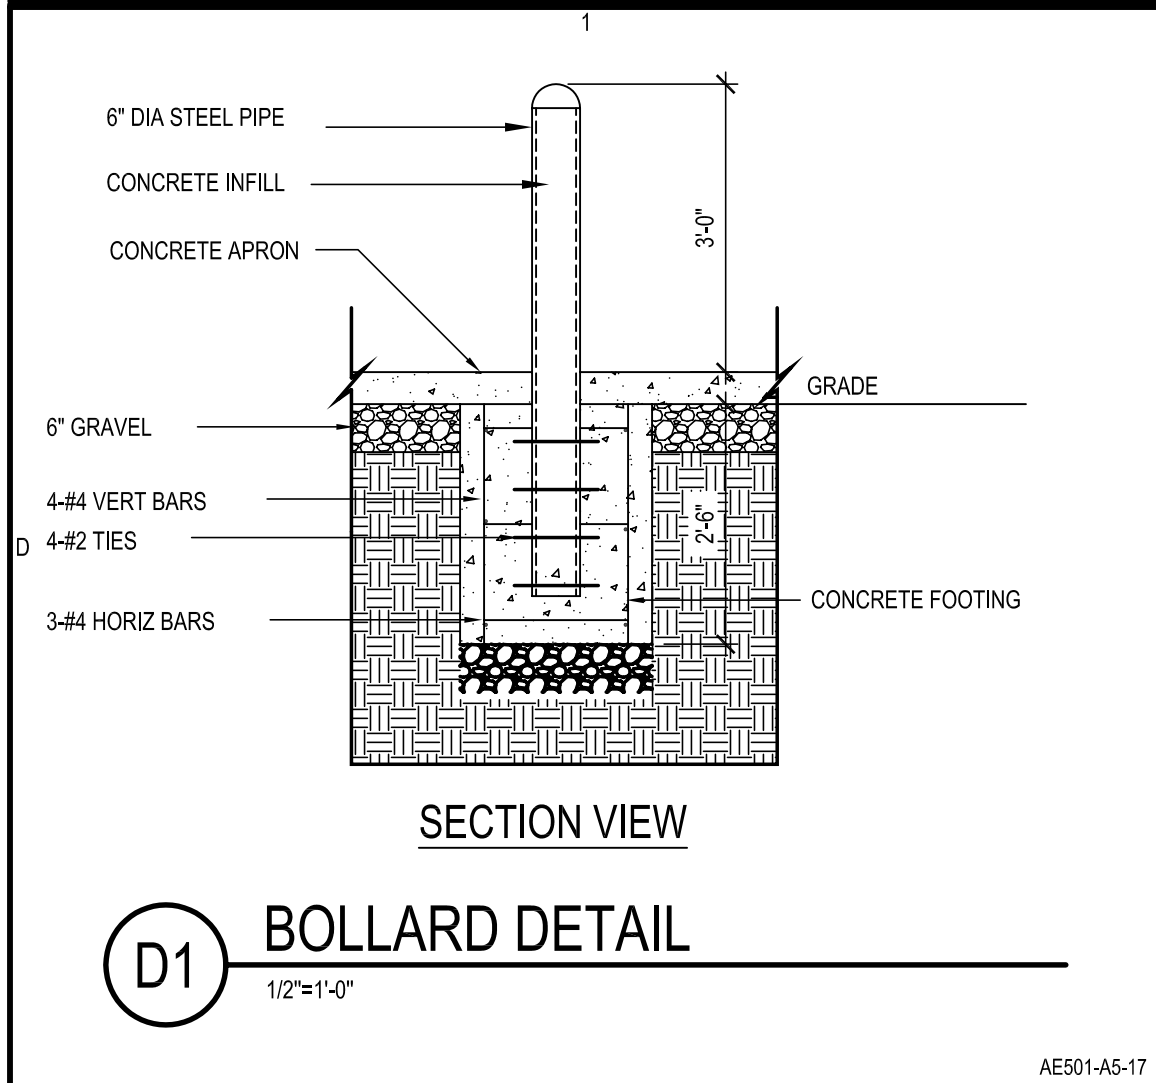


D1 BOLLARD DETAIL  
1/2"=1'-0"

AE501-AS-17

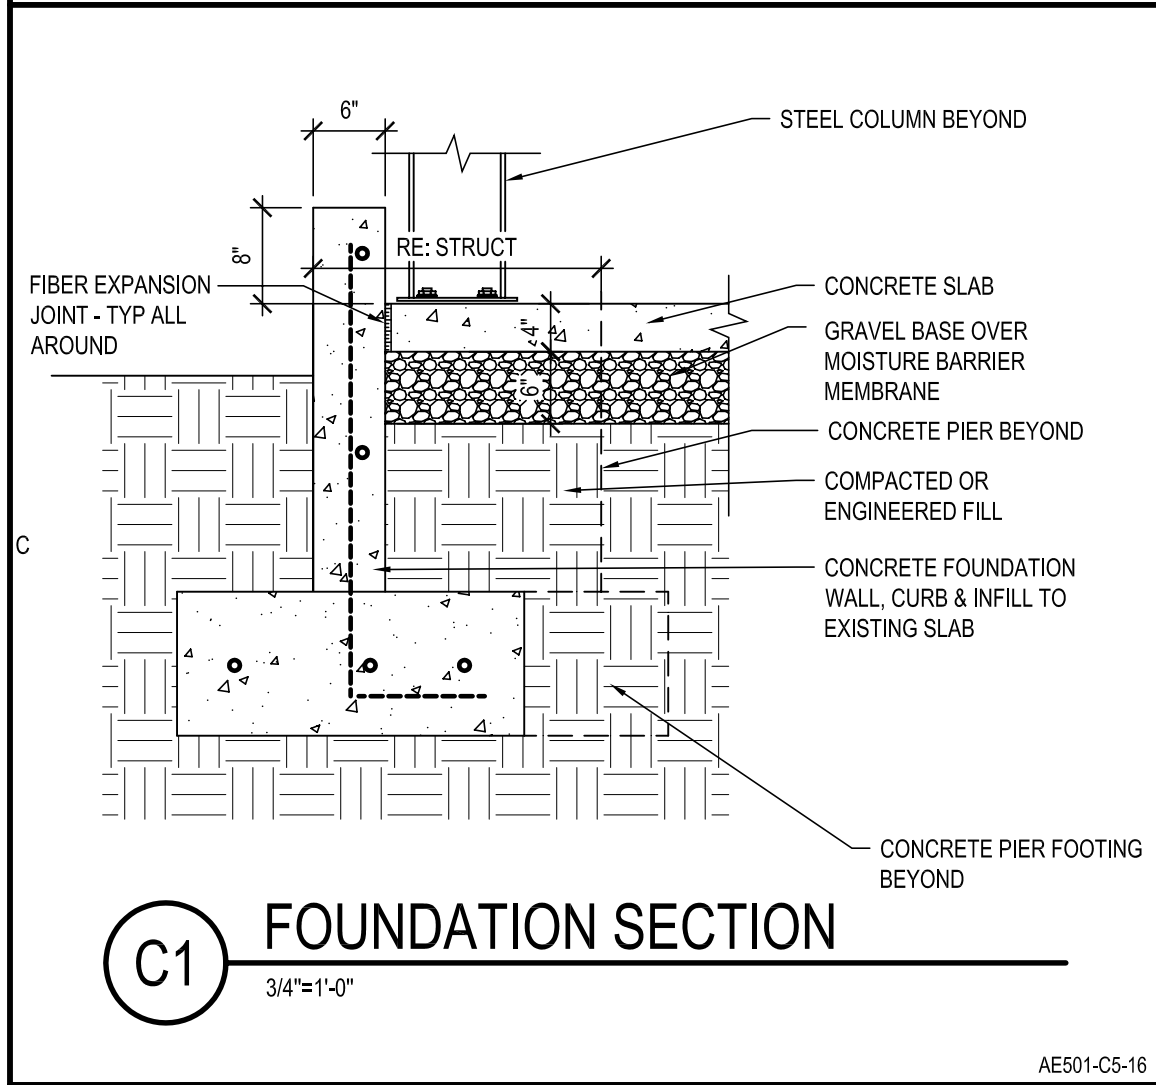


C1 FOUNDATION SECTION  
3/4"=1'-0"

AE501-CS-16

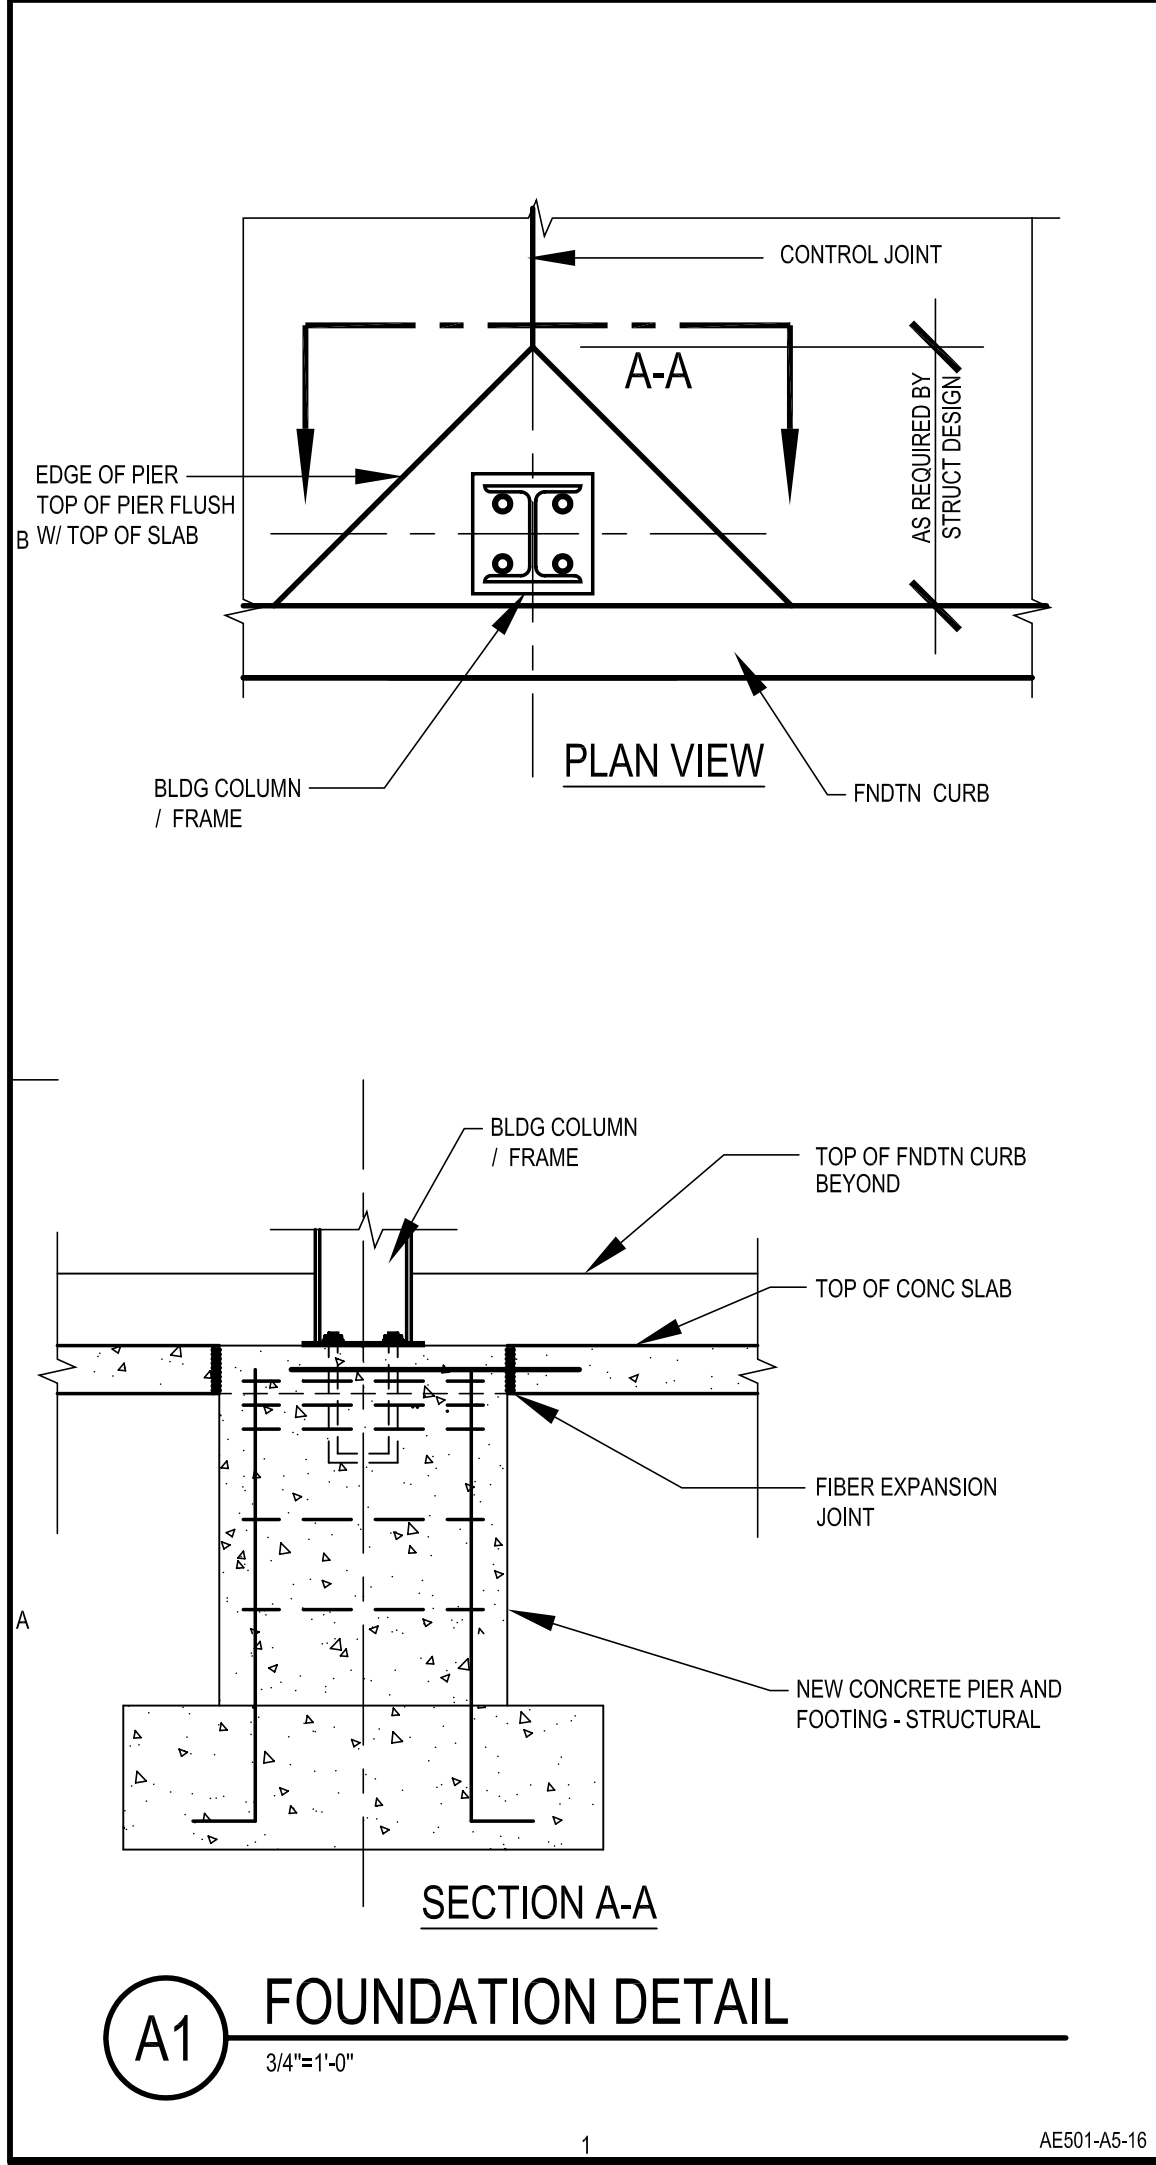


A1 FOUNDATION DETAIL  
3/4"=1'-0"

AE501-AS-16

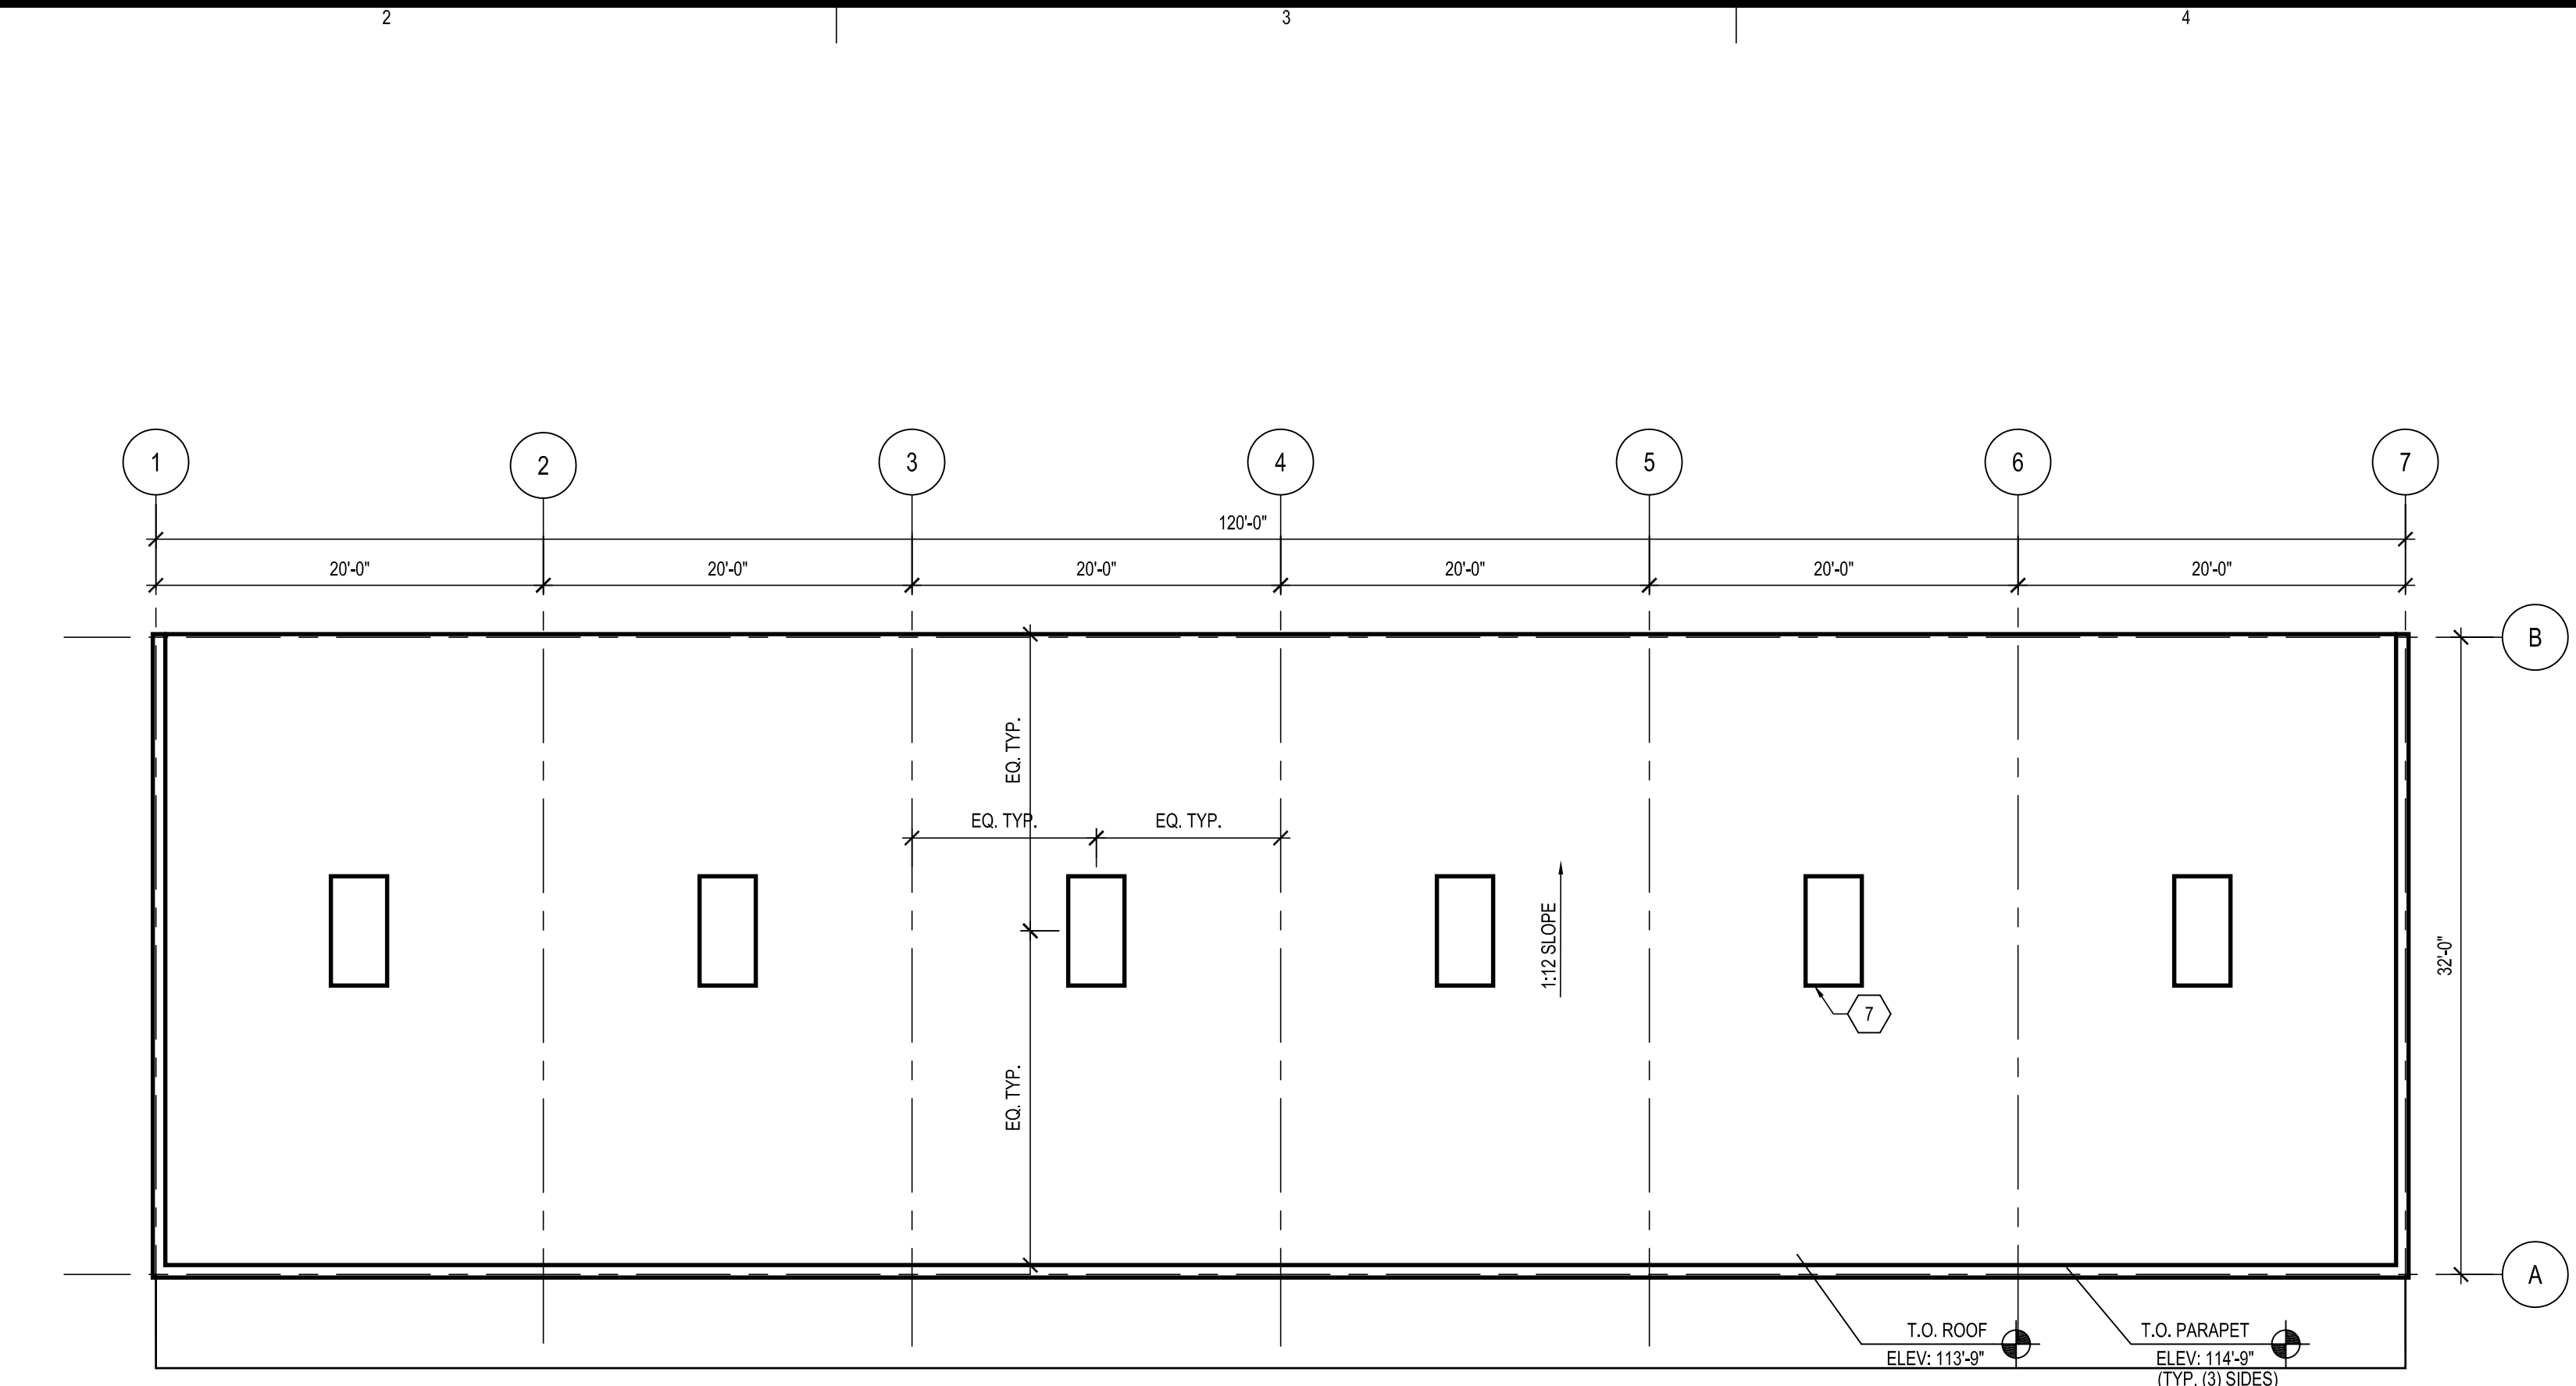

B2 ROOF PLAN  
1/8"=1'-0"

AE\_BASE-66

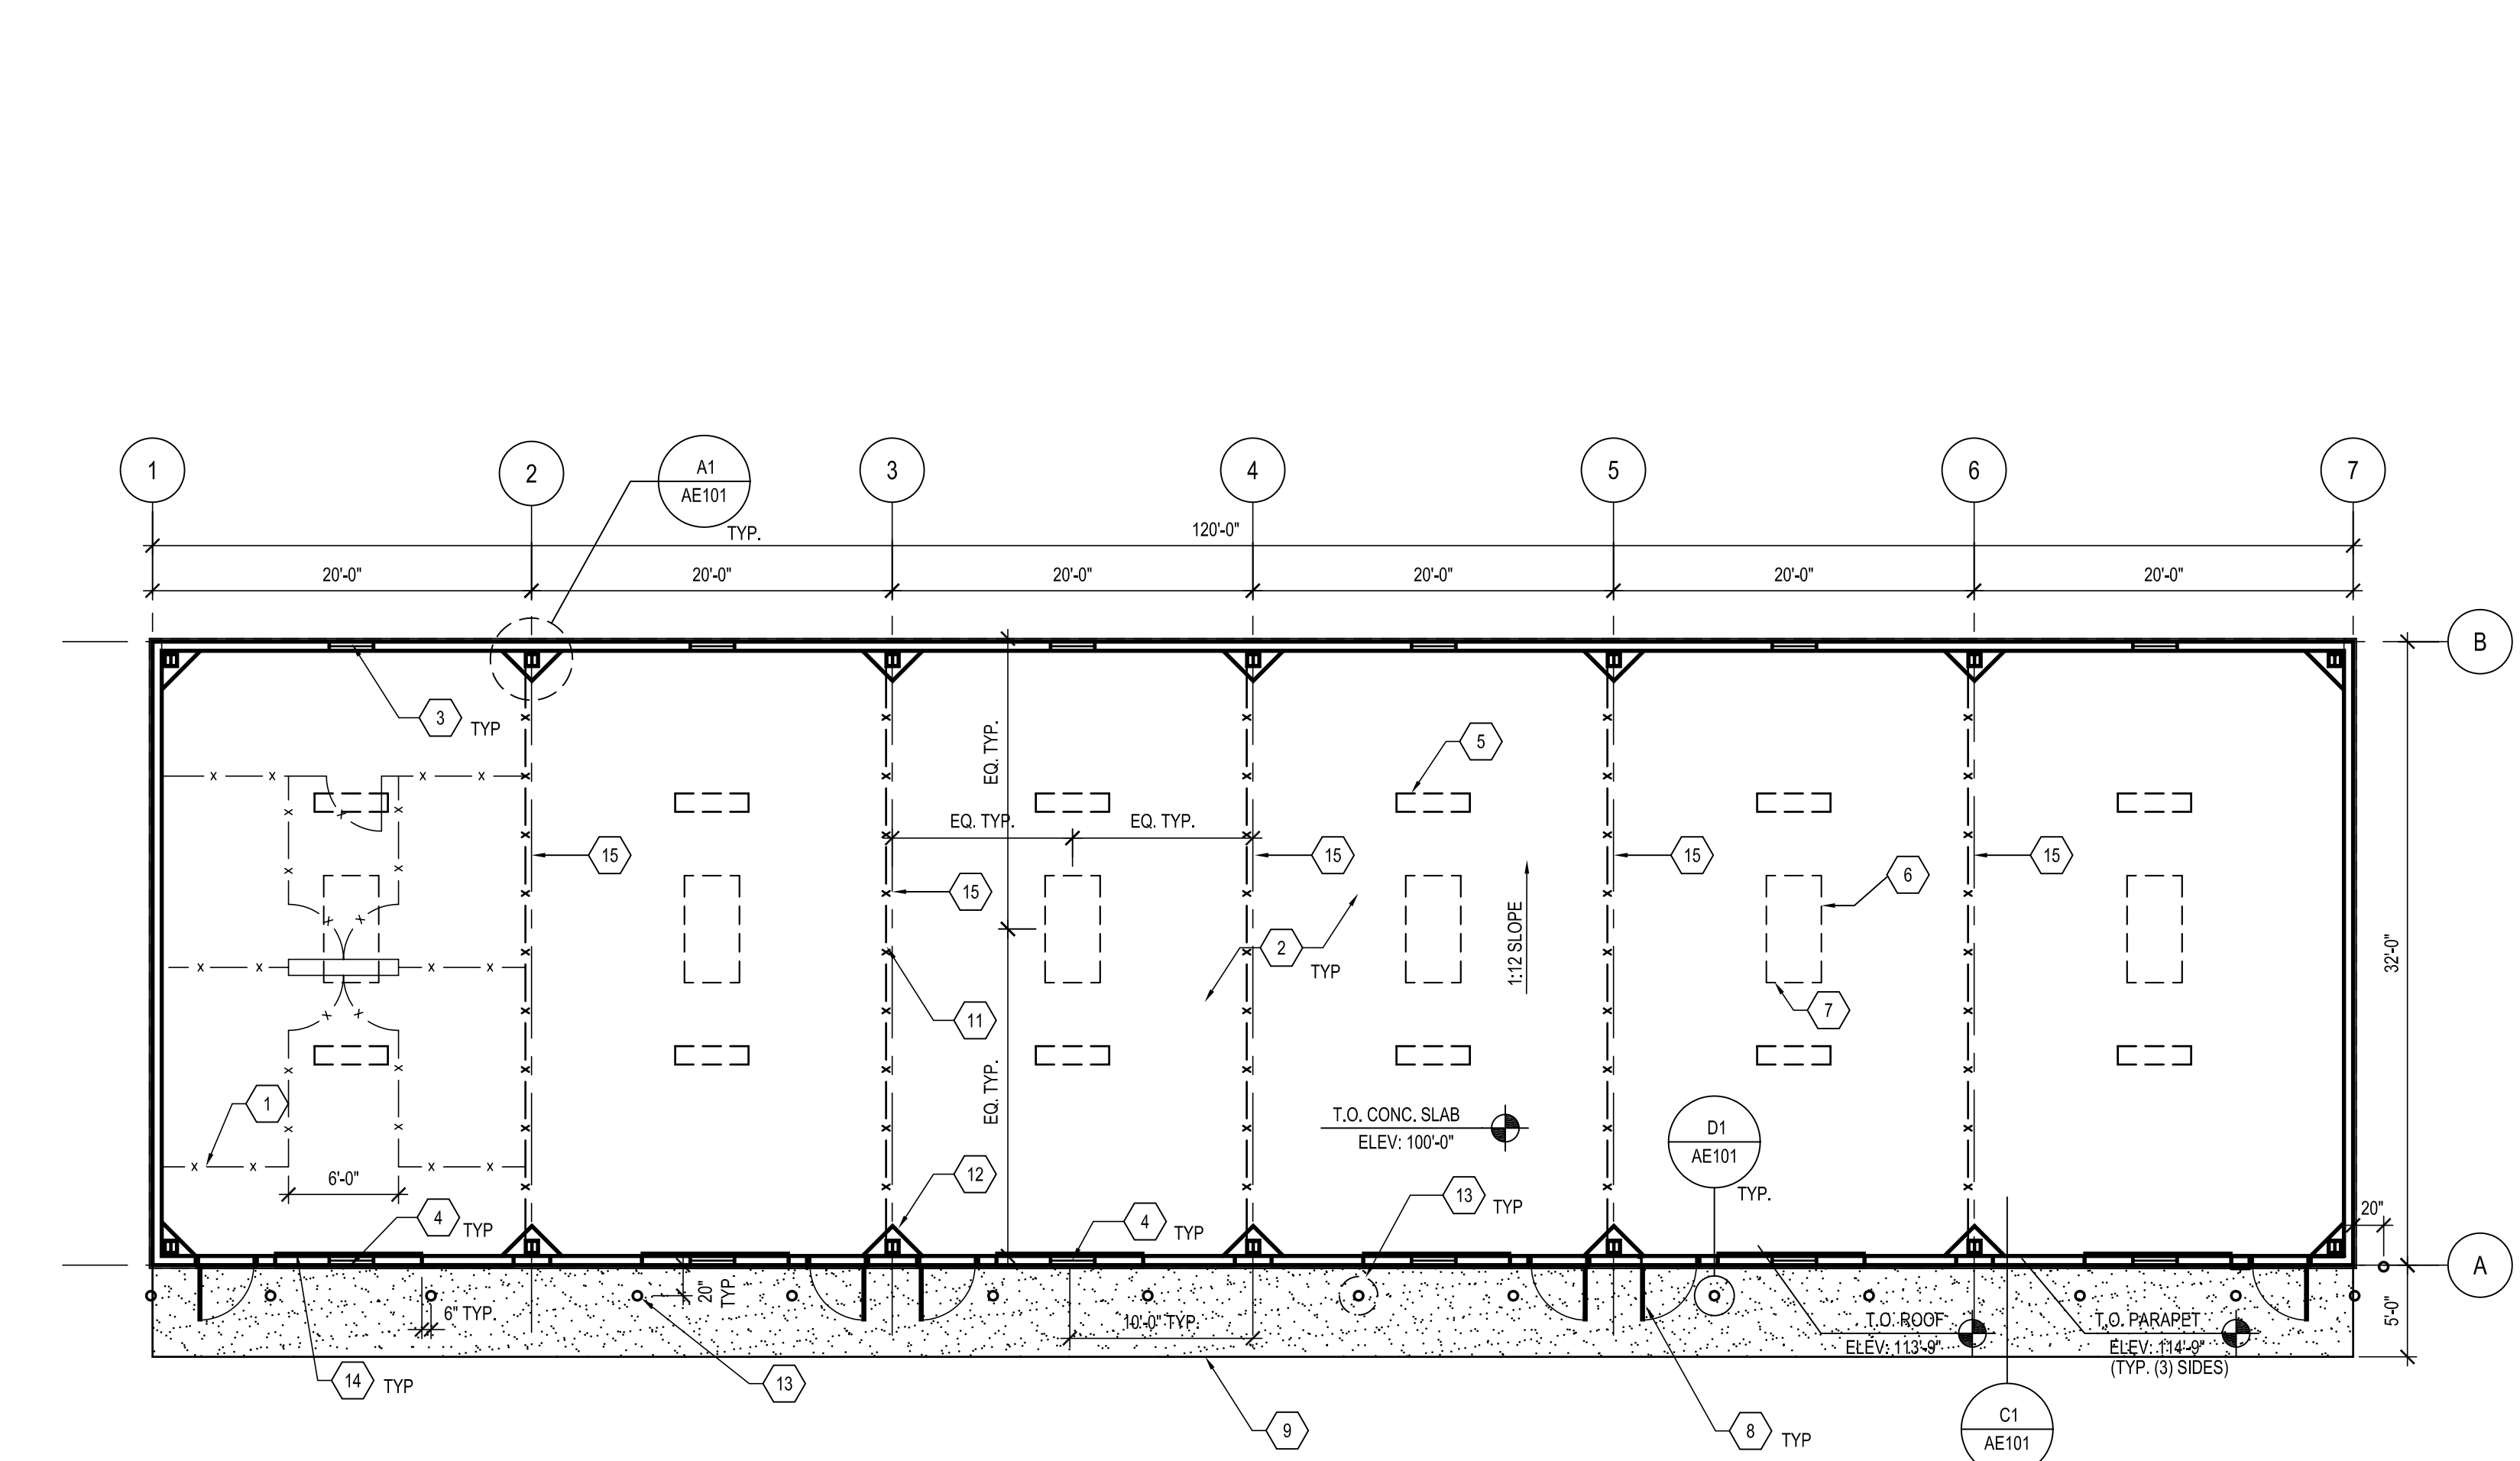

B1 MAIN FLOOR PLAN  
1/8"=1'-0"

AE501-CS-16

- ### REFERENCE NOTES
1. ALTERNATE #1: PROVIDE FLOOR TO DECK WIRE MESH PARTITIONS, FRAMES, 3'-0"x7'-0" GATES AND HARDWARE AS SHOWN FOR EACH OF SIX UNITS TO BE INSTALLED BY THE OWNER - PRICE PER BAY - IN ADDITION TO THE PARTITIONS BETWEEN EACH UNIT ALREADY IN CONTRACT.
  2. NEW CONCRETE SLAB
  3. 30"x12" LOUVERED VENT W/ BUG SCREEN @ 12" A.F.F. - TYPICAL @ EACH BAY
  4. 30"x12" LOUVERED VENT W/ BUG SCREEN @ 12" OFF CLG - TYPICAL
  5. LIGHT FIXTURE ABOVE, TYP. - SEE ELECTRICAL.
  6. SKYLIGHT OR TRANSLUCENT PANEL ABOVE, TYP.
  7. SKYLIGHT OR TRANSLUCENT PANEL BY BUILDING MANUFACTURER - 20 S.F. MIN.
  8. 36" HOLLOW METAL DOOR IN HOLLOW METAL FRAME.
  9. 6" THICK CONCRETE OVER GRAVEL BASE, ALL OVER ENGINEERED FILL PER SOIL REPORT
  10. NOT USED
  11. WIRE MESH PARTITION, FLOOR TO DECK.
  12. CONCRETE PIERS & STEEL COLUMNS, TYP. STRUCTURE AND CONCRETE TO BE VERIFIED BY BUILDING MANUFACTURER.
  13. 6" PIPE CONCRETE FILLED BOLLARDS - PAINT YELLOW.
  14. 96"x 120" METAL OVERHEAD DOOR.
  15. CRACK CONTROL JOINT IN SLAB FROM PIER TO PIER @ EACH GRID LINE (TYP @ ALL GRIDS)

- ### GENERAL NOTES
1. NOTIFY ARCHITECT IF ANY EXISTING CONDITIONS VARY FROM THOSE SHOWN ON THE DRAWINGS.
  2. REPAIR DAMAGE TO EXISTING ELEMENTS TO REMAIN RESULTING FROM DEMOLITION.
  3. STRUCTURAL DESIGN TO BE PROVIDED BY BUILDING MANUFACTURER.

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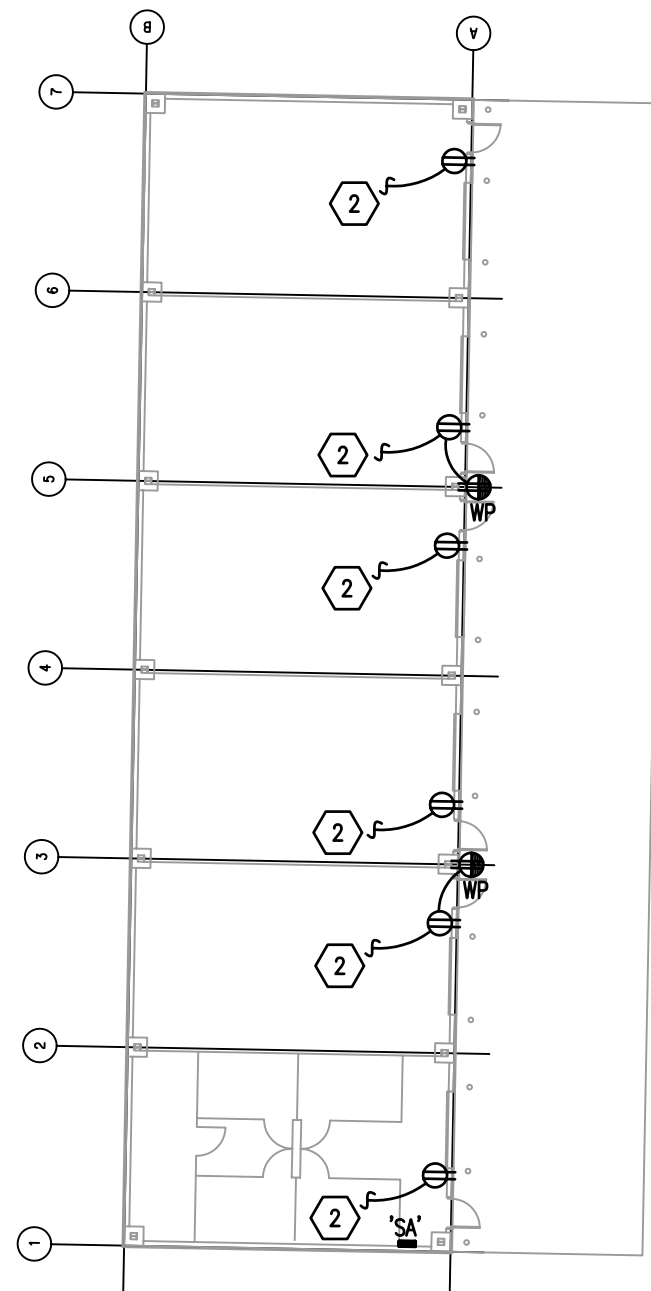
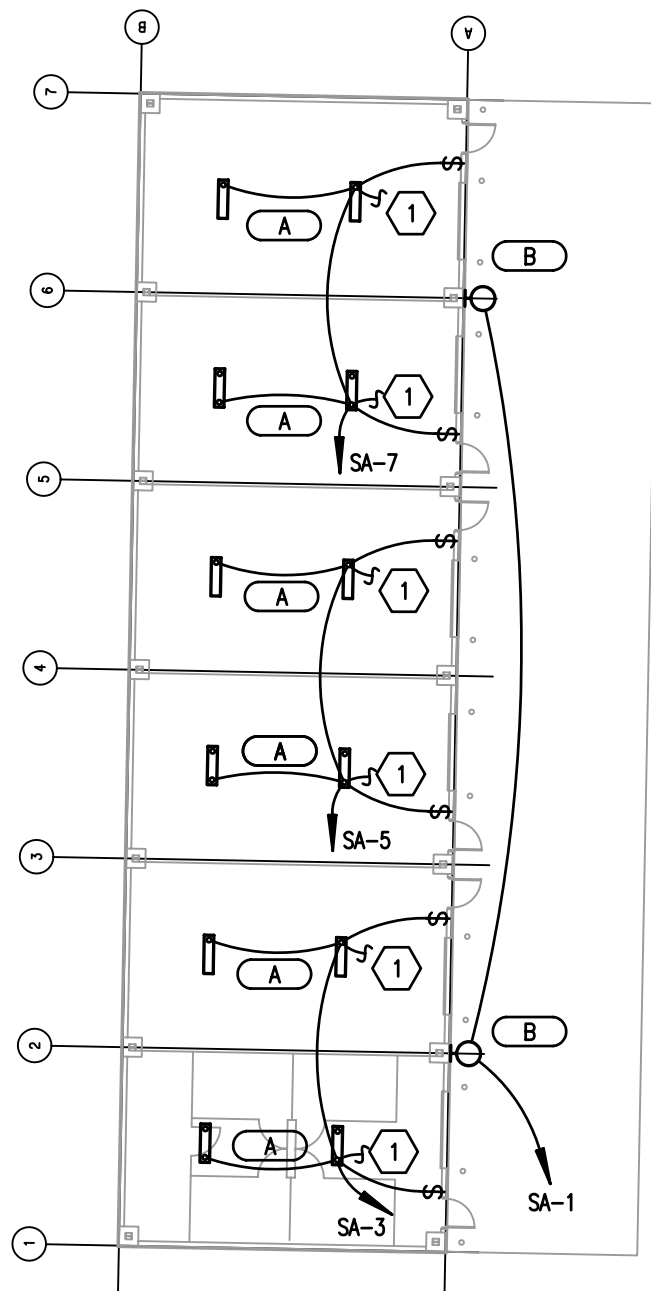
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CAD DWG FILE: ae101.dwg  
DRAWN BY: SJF  
CHECKED BY: DT

PLANS AND DETAILS

AE101  
SHEET 3 OF 4

FIXTURE SCHEDULE				
TYPE	DESCRIPTION	CATALOG NUMBER	VOLTS	LAMPS
A	2 LAMP T8 FLUORESCENT INDUSTRIAL FIXTURE WITH COLD WEATHER ELECTRONIC BALLAST	LITHONIA AFST 232 120 CW METALUX ECM 232 120V CW LIGHTOLIER TF4S232 120 SO CW DAY-BRITE 1F 232-PPS-120-LT COLUMBIA KL4-232-PRST-EB8Z 120	120	(2) F032/835
B	250 WATT METAL HALIDE WALL PACK WITH PHOTOCELL	LITHONIA TWH 250M 120 PE LUMARK MH WL 250 120V PE GENERAL ELECTRIC WM425MO/PEK-120 DAY-BRITE WLR 250M 12-WLS-PEC12 HUBBELL PGM-250H-128-1-PBT-1	120	(1) 250W MH

LIGHT FIXTURE ABBREVIATION SCHEDULE		LIGHT FIXTURE GENERAL NOTES	
NOTE: NOT ALL ABBREVIATIONS WILL NECESSARILY BE USED.		<div>1. REFER TO THE ARCHITECTURAL REFLECTED CEILING PLANS FOR LOCATIONS OF LIGHT FIXTURES. BRING ALL DISCREPANCIES OF LOCATIONS AND QUANTITIES TO THE ATTENTION OF THE ARCHITECT AND ELECTRICAL ENGINEER PRIOR TO BIDDING.</div> <div>2. REFER TO ARCHITECTURAL ELEVATIONS FOR MOUNTING HEIGHTS AND LOCATIONS OF LIGHT FIXTURES. BRING ALL DISCREPANCIES TO THE ATTENTION OF THE ARCHITECT PRIOR TO BIDDING.</div> <div>3. REFER TO THE SPECIFICATIONS FOR OTHER LIGHT FIXTURE, FUSING, BALLAST, AND LAMP REQUIREMENTS AND ACCEPTABLE MANUFACTURERS.</div> <div>4. REFER TO ARCHITECTURAL DRAWINGS AND SPECIFICATIONS FOR LOUVER REQUIREMENTS AS REQUIRED.</div> <div>5. CONFIRM AVAILABLE MOUNTING DEPTHS OF ALL LIGHT FIXTURES AND COMPARE WITH DEPTHS SHOWN ON SHOP DRAWINGS. BRING ALL POTENTIAL CONFLICT AREAS TO THE ATTENTION OF THE ARCHITECT AND ELECTRICAL ENGINEER PRIOR TO RELEASE.</div>	
A.F.F.	ABOVE FINISHED FLOOR		
WALL@CLG	WALL MOUNT AT CORNER OF WALL AND CEILING		
CCBA	CUSTOM PAINTED COLOR AS SELECTED BY THE ARCHITECT		
SCBA	STANDARD PAINTED COLOR AS SELECTED BY THE ARCHITECT		
CFBA	CUSTOM FINISH AS SELECTED BY THE ARCHITECT		
SFBA	STANDARD FINISH AS SELECTED BY THE ARCHITECT		
MOD	MODIFY STANDARD LIGHT FIXTURE AS INDICATED		
BIDDING REQUIREMENTS			
<div>1. BID ONLY PRODUCTS THAT ARE SPECIFIED OR APPROVED BY ADDENDUM.</div> <div>2. PACKAGING OF LIGHT FIXTURES WITH OTHER SYSTEMS IS <u>NOT</u> ALLOWED.</div> <div>3. WHEN ONLY ONE PRODUCT IS APPROVED FOR BIDDING, THE PRICE FOR THAT ITEM SHALL BE BROKEN OUT SEPARATELY WHEN SUBMITTING PRICING TO VARIOUS DISTRIBUTORS AND/OR CONTRACTORS.</div> <div>4. WHEN A CONTRADICTION EXISTS BETWEEN A SPECIFIC MODEL NUMBER AND THE DESCRIPTION, THE DESCRIPTION SHALL GOVERN.</div>			
PRIOR APPROVAL REQUIREMENTS			
<div>1. PRIOR APPROVAL IS REQUIRED BEFORE BIDDING THIS PROJECT.</div> <div>2. PRIOR APPROVALS SHALL BE SUBMITTED TO THE ELECTRICAL ENGINEER'S OFFICE AT LEAST (8) EIGHT WORKING DAYS BEFORE THE BID. PRIOR APPROVALS RECEIVED AFTER THIS TIME PERIOD SHALL BE REJECTED.</div> <div>3. PRIOR APPROVALS SHALL BE SIGNED BY A PRINCIPAL OF THE SUBMITTING ORGANIZATION STATING THAT THEY HAVE PREPARED AND/OR REVIEWED THE SUBMITTAL AND THAT THE PRODUCTS PROPOSED ARE EQUIVALENT TO THOSE SPECIFIED. ANY EXCEPTIONS SHALL BE SO NOTED.</div> <div>4. ITEMS THAT ARE SUBMITTED AND HAVE BEEN APPROVED WILL BE LISTED IN THE ADDENDUM(S). VERBAL APPROVAL WILL <u>NOT BE</u> GIVEN ON ANY ITEM.</div> <div>5. IT IS <u>NOT</u> THE RESPONSIBILITY OF THE ELECTRICAL ENGINEER TO NOTIFY THE SUBMITTING PARTY OF ERRORS IN THE SUBMITTAL. NOTIFICATION OF ERRORS BY THE ELECTRICAL ENGINEER PRIOR TO ISSUANCE OF THE ADDENDUM(S) MAY NOT BE GIVEN.</div> <div>6. PRIOR APPROVALS SHALL CONSIST OF TWO SETS OF CUT SHEETS DESCRIBING THE PRODUCTS BEING SUBMITTED AS EQUIVALENTS. FAXES ARE <u>NOT</u> ACCEPTABLE. ALL SPECIFICATION INFORMATION SHALL BE CLEARLY MARKED, WITH NON-APPLICABLE INFORMATION CROSSED OUT. COMPLETE PHOTOMETRIC DATA SHALL BE PROVIDED. PRODUCTS WITHOUT PHOTOMETRIC DATA WILL <u>NOT BE</u> APPROVED.</div> <div>7. SUPPLY POINT-BY-POINTS AS REQUIRED BY THE ELECTRICAL ENGINEER AND/OR LIGHTING DESIGNER.</div> <div>8. SAMPLE FIXTURES MUST BE SUPPLIED WITH A CORD, PLUG AND 120V BALLAST.</div>			
LIGHTING SHOP DRAWING REQUIREMENTS			
<div>1. REFER TO SPECIFICATIONS 16001, 16510 &amp; 16551.</div> <div>2. MUST INCLUDE BALLAST AND LAMP CUT SHEETS.</div> <div>3. LINEAR LIGHTING MUST INCLUDE DETAILED DRAWINGS WITH SUPPORT DETAILS, STEM LOCATIONS AND HAVE ALL LENGTHS IDENTIFIED WITH STEM LOCATIONS.</div> <div>4. COLOR SAMPLES MUST BE INCLUDED IN FIRST SUBMITTAL.</div> <div>5. CUT SHEETS MUST BE STAMPED BY THE FACTORY REPRESENTATIVE'S COMPANY NAME.</div> <div>6. VALUE ENGINEERING CONDUCTED WITHOUT THE DESIGN TEAM IE; ARCHITECT, OWNER, ENGINEER &amp; LIGHTING CONSULTANT/DESIGNER WILL NOT BE ALLOWED, REVIEWED OR APPROVED.</div> <div>7. PROVIDE A LIST OF SPARE PARTS, EQUIPMENT &amp; LAMPS.</div>			




GENERAL NOTES	
1.	CONSULT ARCHITECTURAL REFLECTED CEILING PLANS FOR EXACT LOCATION OF ALL LIGHTING FIXTURES.
2.	VERIFY ALL EQUIPMENT DIMENSIONS AND LOCATIONS BEFORE BEGINNING ROUGH IN. CONSULT ALL APPLICABLE CONTRACT DRAWINGS AND SHOP DRAWINGS TO INSURE NEC CODE CLEARANCES REQUIRED AROUND ALL ELECTRICAL EQUIPMENT.
3.	CONTRACTOR SHALL VERIFY ALL ELECTRICAL LOADS (VOLTAGE, PHASE, CONNECTION REQUIREMENTS, ETC.) OF EQUIPMENT FURNISHED UNDER DIVISION 15 WITH APPROVED MECHANICAL SHOP DRAWINGS BEFORE BEGINNING ROUGH IN.
4.	SEE SECTION 16510 OF THE SPECIFICATION REQUIRED COORDINATION MEETINGS WITH MECHANICAL AND CEILING CONTRACTORS.
5.	SEE APPLICABLE SHOP DRAWINGS FOR ROUGH IN LOCATION OF ALL EQUIPMENT, WIRING DEVICES, ETC. WHERE APPLICABLE MOUNT ALL WIRING DEVICES ABOVE BACK SPLASH EXCEPT THOSE SERVING UNDER COUNTER EQUIPMENT.
6.	SEE SPECIFICATION FOR ENERGY SAVING LAMP AND BALLAST REQUIREMENTS.
7.	FINISHES OF ALL LIGHT FIXTURES SHALL BE AS SELECTED BY ARCHITECT.
8.	THE ELECTRICAL CONTRACTOR SHALL NOTIFY AND COOPERATE WITH THE MECHANICAL CONTRACTOR SUCH THAT NO PIPING, DUCTS, OR EQUIPMENT FOREIGN TO THE OPERATION OF THE ELECTRICAL EQUIPMENT SHALL BE PERMITTED TO BE INSTALLED IN, ENTER OR PASS THRU ELECTRICAL ROOMS OR SPACES, OR ABOVE OR BELOW ELECTRICAL EQUIPMENT IN OTHER AREAS.
9.	ELECTRICAL BOXES SHALL NOT BE LOCATED IN MASONRY COLUMNS IN BRICK WALLS OR IN GROUTED CELLS ADJACENT TO OPENINGS. COORDINATE LOCATION OF BOXES WITH MASONRY CONTRACTOR.
10.	ALL PENETRATIONS OF FIRE RATED FLOORS, WALLS, AND CEILINGS SHALL BE SEALED WITH APPROVED MATERIAL TO MAINTAIN FIRE RATING OF SURFACE PENETRATED.
11.	CIRCUITS EXTENDING OVER 70' FOR 120 VOLT AND 165' FOR 277 VOLT 20 AMP CIRCUITS SHALL BE RUN WITH MINIMUM #10 CONDUCTORS.
12.	ALL CONDUIT SHALL BE 3/4" MINIMUM.

SHEET KEYNOTES	
①	CIRCUIT TO RECEPTACLE THIS BAY.
②	CIRCUIT TO LIGHT FIXTURE THIS BAY.

ELECTRICAL SYMBOL SCHEDULE			
1. SEE FIXTURE SCHEDULE FOR TYPE, MOUNTING AND WATTAGE. 2. HEIGHT MEASURED TO CENTER LINE OF THE BOX FROM THE FINISH FLOOR. 3. REFER TO DRAWINGS FOR DIRECTIONAL ARROWS. 4. SUBSCRIPT KEYS SWITCH TO FIXTURES CONTROLLED. 5. NEMA TYPE 'ND' NON-FUSED UNLESS NOTED 'F' (FUSED). USE 'HD' 480 V. 6. HEIGHT TO BE THE LOWER OF EITHER 80" A.F.F. OR 6" BELOW CEILING. 7. PROVIDE H.O.A. AND S.S. PUSHBUTTONS AS REQUIRED. 8. DOUBLE ARROWS DENOTE A DOUBLE FACE UNIT. 9. COORDINATE WITH MILLWORK SHOP DRAWINGS AND ELEVATIONS FOR HEIGHT. 10. SUBSCRIPT DENOTES NEMA CONFIGURATION. 11. HEIGHT MEASURED TO BOTTOM OF THE BOX FROM FINISH FLOOR.			
STANDARD MOUNTING HEIGHT UNLESS OTHERWISE NOTED ON PLANS			
SYMBOL	DESCRIPTION	MOUNTING HEIGHT	NOTES
→	ONE CIRCUIT, TWO WIRE HOME RUN TO PANEL		
→→	2 CIRCUIT, 3 WIRE, COMMON NEUTRAL HOME RUN		
→→→	3 CIRCUIT, 4 WIRE, COMMON NEUTRAL HOME RUN		
—	CONDUIT RUN CONCEALED IN WALL OR CEILING		
—	CONDUIT RUN CONCEALED IN FLOOR OR GROUND		
○	CONDUIT UP		
●	CONDUIT DOWN		
—	CONDUIT STUB LOCATION	CAP CONDUIT	
≡	CABLE TRAY	AS NOTED	
○	CEILING LIGHT FIXTURE		1.
○	WALL LIGHT FIXTURE	AS NOTED	1.
□	RECESSED DOWNLIGHT FIXTURE	CEILING	1.
□	FLUORESCENT LIGHT FIXTURE	AS NOTED	1
□	FLUORESCENT EGRESS LIGHT FIXTURE	AS NOTED	UNSWITCHED
■	AREA LIGHT POLE AND FIXTURE	CONCRETE BASE	SEE DIAGRAM
△	FLOOD OR TRACK FIXTURE	AS NOTED	
⊗	CEILING MOUNTED EXIT LIGHT	CEILING	1.3.8.
⊗	WALL MOUNTED EXIT LIGHT	AS NOTED	1.3.8.
\$	SINGLE POLE SWITCH	+4'-0"	2.
\$ <sup>1</sup>	SINGLE POLE SWITCH	+4'-0"	4. 2.
\$ <sup>3</sup>	THREE-WAY SWITCH	+4'-0"	2.
\$ <sup>4</sup>	FOUR-WAY SWITCH	+4'-0"	2.
\$ <sup>K</sup>	KEY OPERATED SWITCH	+4'-0"	2.
\$ <sup>P</sup>	SWITCH WITH PILOT LIGHT	+4'-0"	2.
\$ <sup>D</sup>	VARIABLE INTENSITY SWITCH	+4'-0"	2.
\$ <sup>TM</sup>	TIMER SWITCH	+4'-0"	2.
⊕	POWER PACK	CEILING	SEE DIAGRAM, SPEC.
⊕	DUPLEX RECEPTACLE	UPPER OUTLET SWITCH CONTROLLED	+16" OR AS NOTED 9. 11.
⊕	DUPLEX RECEPTACLE		+16" OR AS NOTED 9. 11.
⊕ <sub>A</sub>	DUPLEX RECEPTACLE		9.
⊕ <sub>WP</sub>	WEATHERPROOF RECEPTACLE		+24" OR AS NOTED 2. 9.
⊕	GROUND FAULT INTERRUPTER DUPLEX RECEPTACLE		+16" OR AS NOTED 9. 11.
⊕	FOURPLEX RECEPTACLE		+16" OR AS NOTED 9. 11.
⊕	SPECIAL PURPOSE OUTLET		+16" OR AS NOTED 10. WITH CAP. 11.
▶	TELEPHONE/DATA OUTLET		+16" OR AS NOTED 9. 11.
▷	TELEPHONE OUTLET	FLOOR	
⊙	JUNCTION BOX ('F' IN FLOOR)	AS NOTED	
⊙	MOTOR OUTLET	TO SUIT EQUIP.	
⊕	PHOTO-ELECTRIC CONTROL	AS NOTED	TORK 2000A
TC	TIME CLOCK	+5'-0"	2.
□	PUSHBUTTON	+4'-0"	2.
□	NON-FUSED DISCONNECT SWITCH	+5'-0"	5.
F	FUSED DISCONNECT SWITCH	+5'-0"	5.
\$ <sup>T</sup>	MANUAL STARTER THERMAL OVERLOAD SWITCH WITH PILOT LIGHT	+4'-0"	2.
□	MAGNETIC STARTER	+5'-0"	7.
□	MAGNETIC STARTER / DISCONNECT COMBINATION	+5'-0"	
VFD	VARIABLE FREQUENCY DRIVE	+6'-6"	
■	PANEL BOARD	TOP AT +6'-0"	
842	ARCHITECTURAL ROOM NUMBER		
A	LIGHT FIXTURE (LETTER DESIGNATES TYPE)		
842	EQUIPMENT NUMBER		

INDEX OF ELECTRICAL DRAWINGS	
EG001	SYMBOLS, SCHEDULES NOTE, & FLOOR PLANS
ES101	ELECTRICAL SITE PLAN
EX101	ONE LINE DIAGRAM & PANELBOARD SCHEDULE

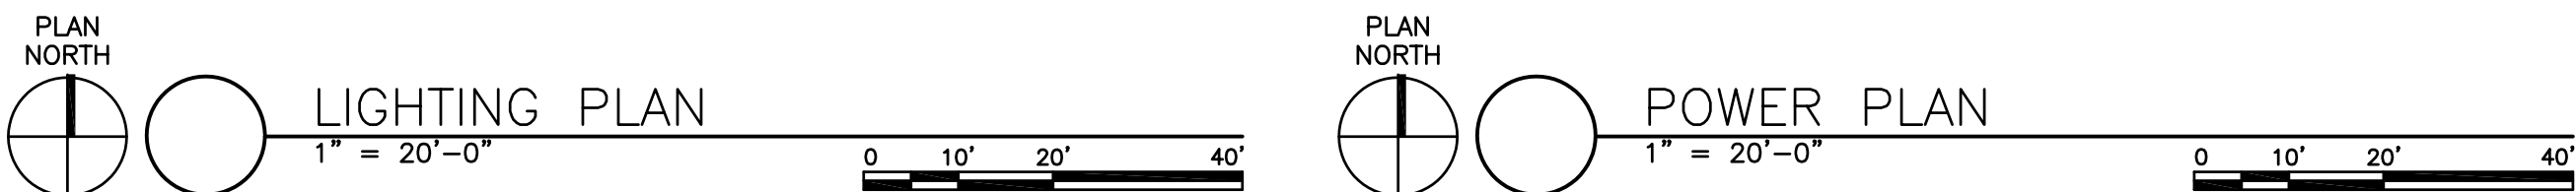

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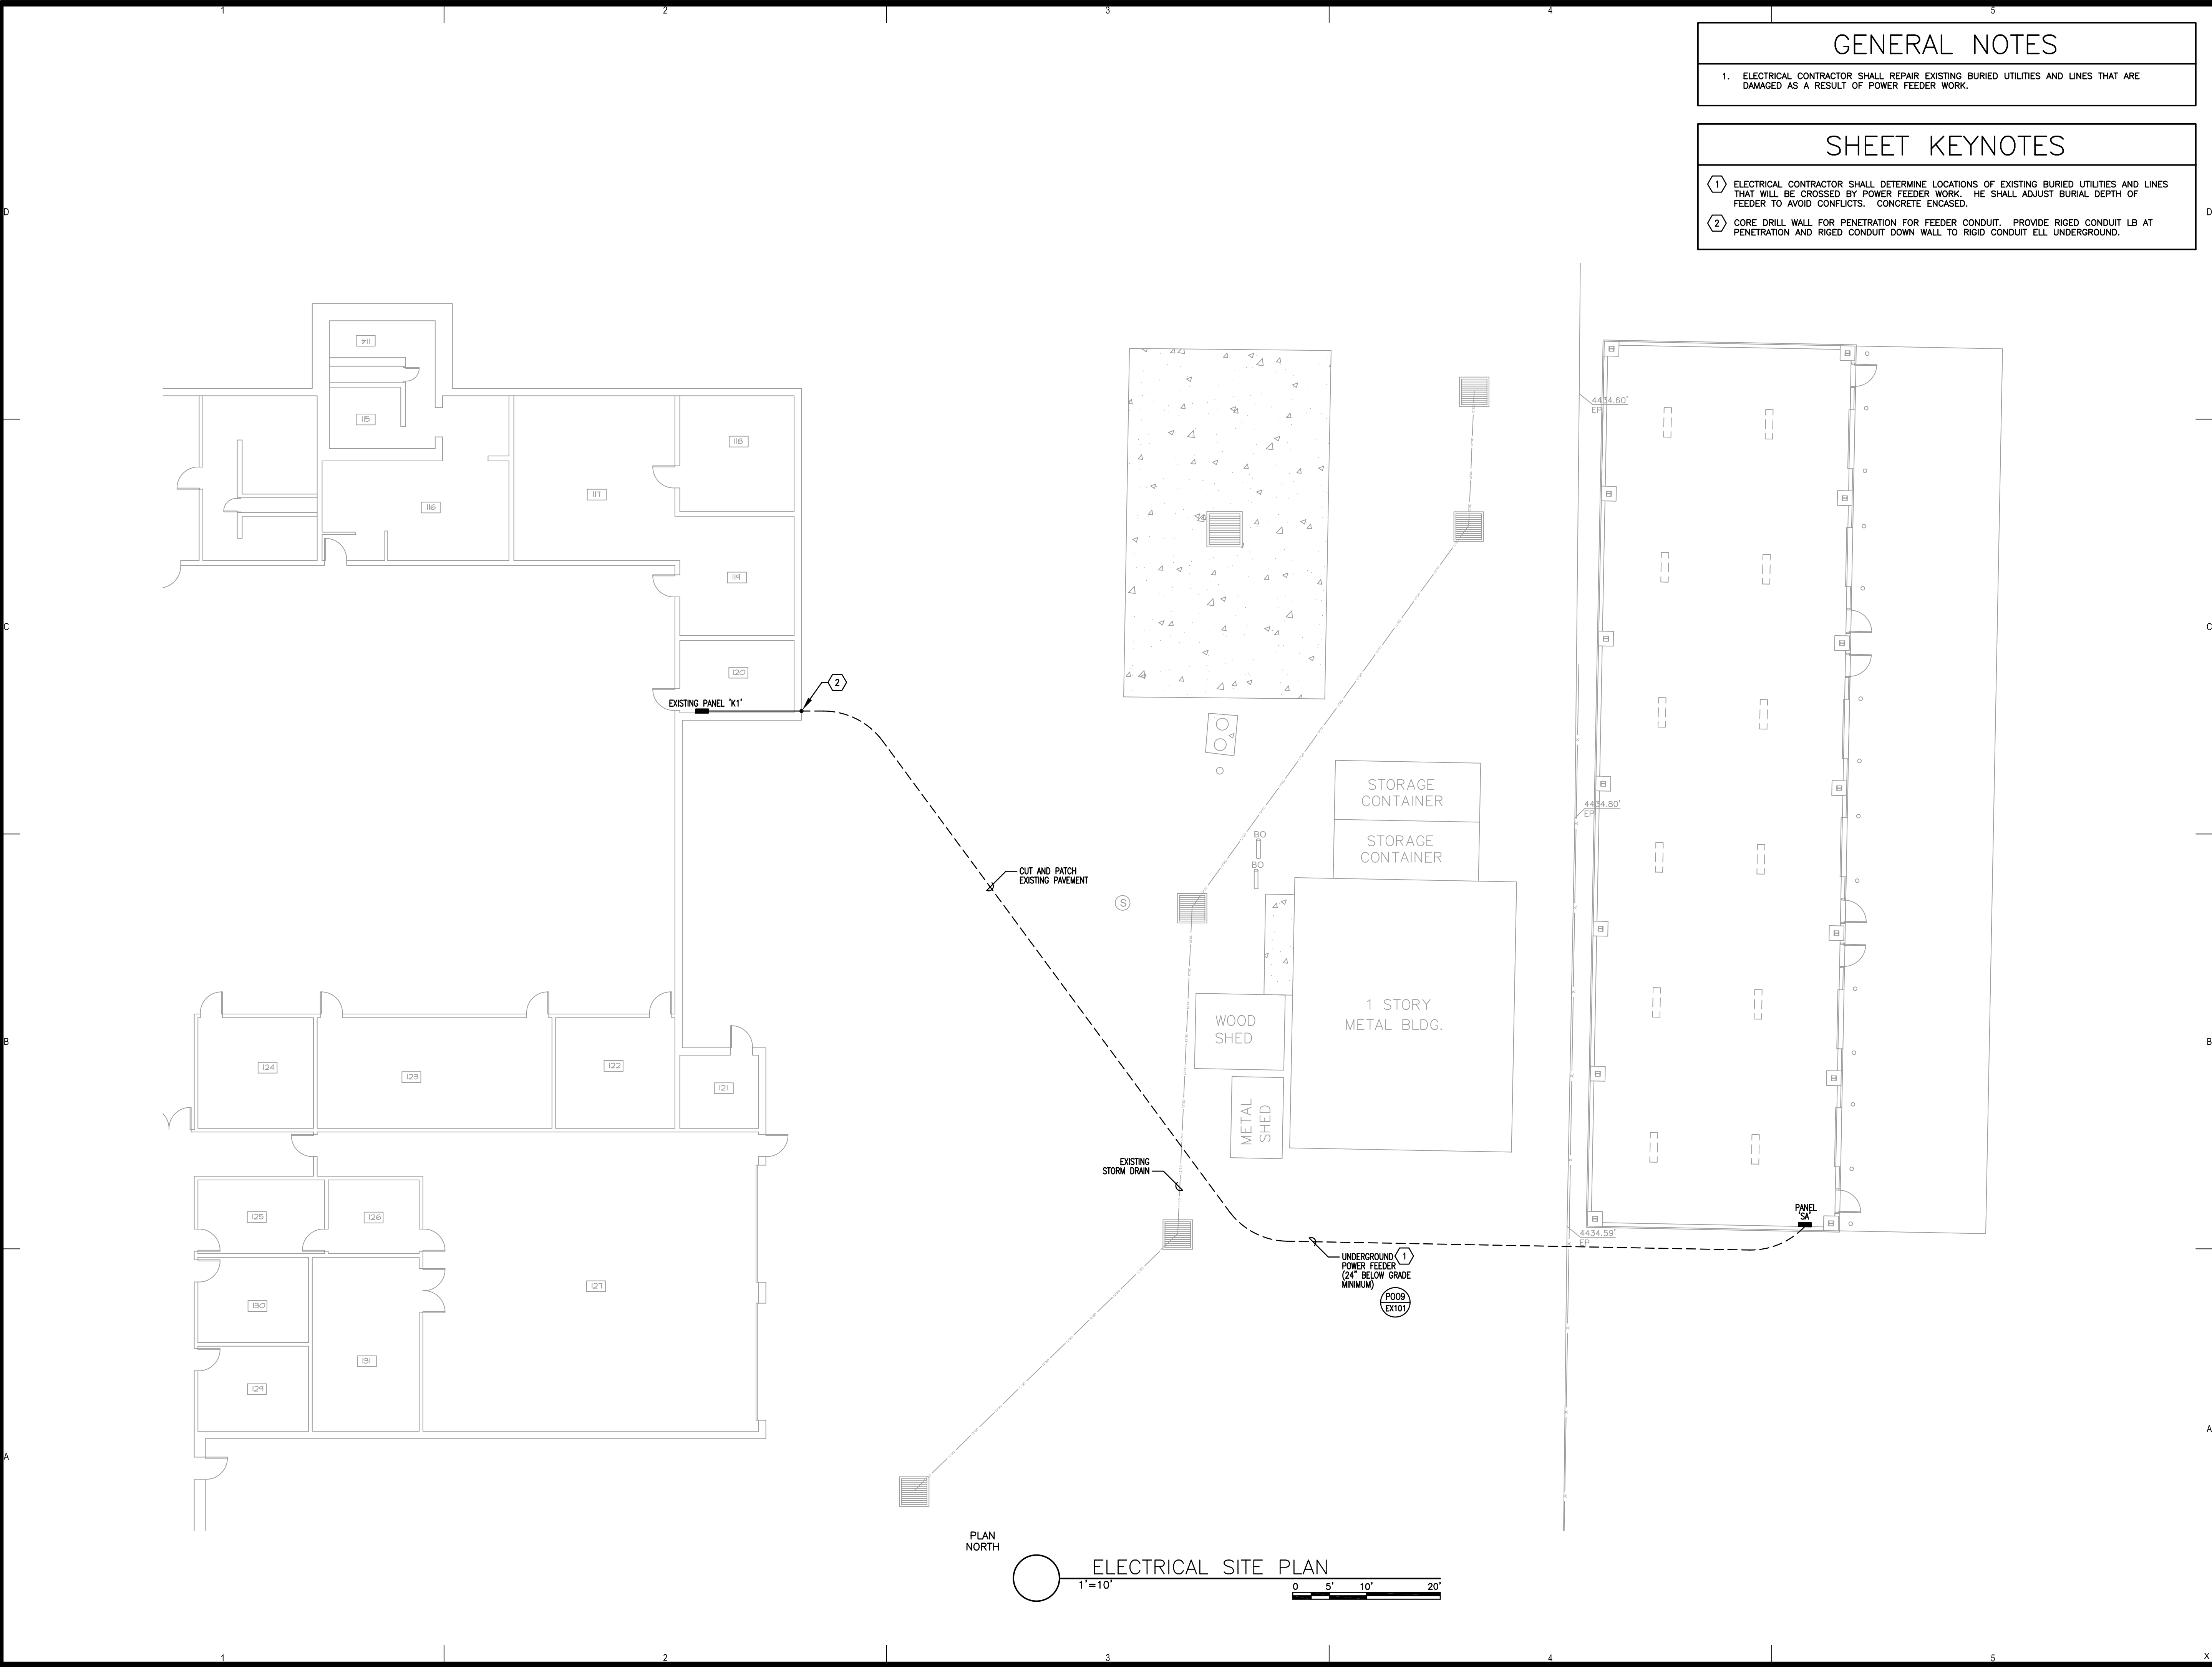
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CD	- 100%	- JULY 22, 2005	
DD	-	-	

PROJECT NO: 05194A  
CAD DWG FILE:  
DRAWN BY: BNA  
CHECKED BY: R.L.W.

SYMBOLS,  
SCHEDULES,  
NOTES & FLOOR  
PLANS

EG001  
SHEET # OF #



GENERAL NOTES

1. ELECTRICAL CONTRACTOR SHALL REPAIR EXISTING BURIED UTILITIES AND LINES THAT ARE DAMAGED AS A RESULT OF POWER FEEDER WORK.

SHEET KEYNOTES

① ELECTRICAL CONTRACTOR SHALL DETERMINE LOCATIONS OF EXISTING BURIED UTILITIES AND LINES THAT WILL BE CROSSED BY POWER FEEDER WORK. HE SHALL ADJUST BURIAL DEPTH OF FEEDER TO AVOID CONFLICTS. CONCRETE ENCASED.

② CORE DRILL WALL FOR PENETRATION FOR FEEDER CONDUIT. PROVIDE RIGID CONDUIT LB AT PENETRATION AND RIGID CONDUIT DOWN WALL TO RIGID CONDUIT ELL UNDERGROUND.

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UTNG LOGAN ARMORY  
UNHEATED STRG. BLDG.  
DFCM PROJ. NO. 05191480  
560 SOUTH 500 WEST  
LOGAN, UTAH

UTAH NATIONAL GUARD  
12953 SOUTH MINUTEMAN DRIVE  
DRAPER, UTAH 84020-1776

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CD	- 100%	- JULY 22, 2005	
DD	-	-	

PROJECT NO: 05194A  
CAD DWG FILE:  
DRAWN BY: BNA  
CHECKED BY: R.L.W.

ELECTRICAL SITE  
PLAN

**ES101**  
SHEET # OF #



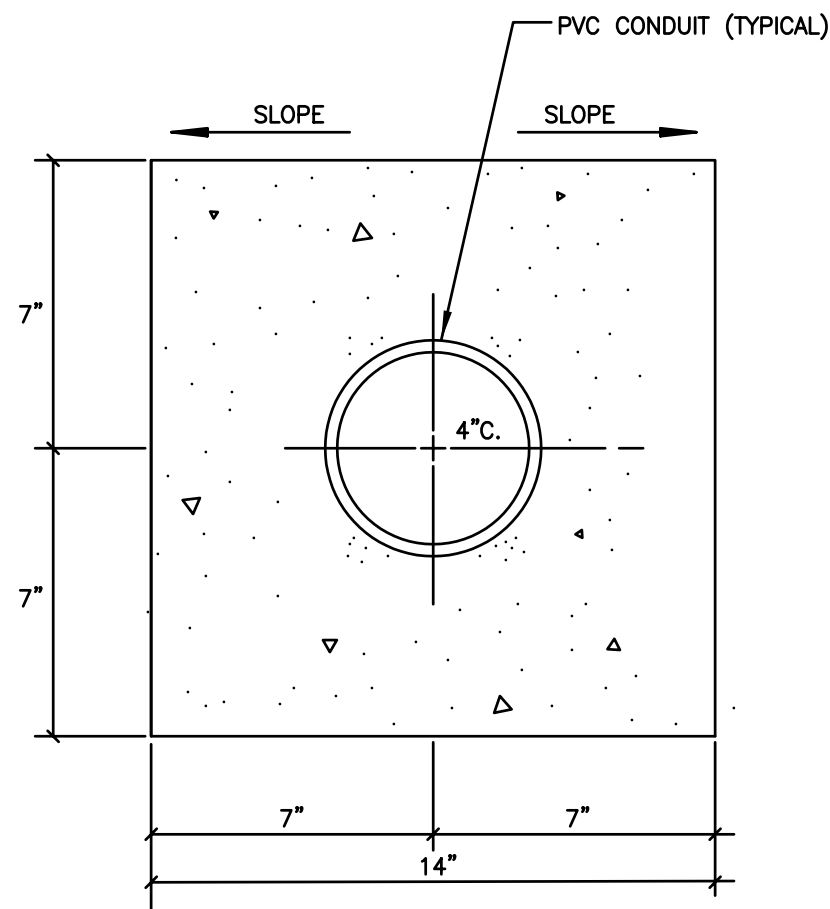


DIAGRAM P009 DUCT BANK NTS

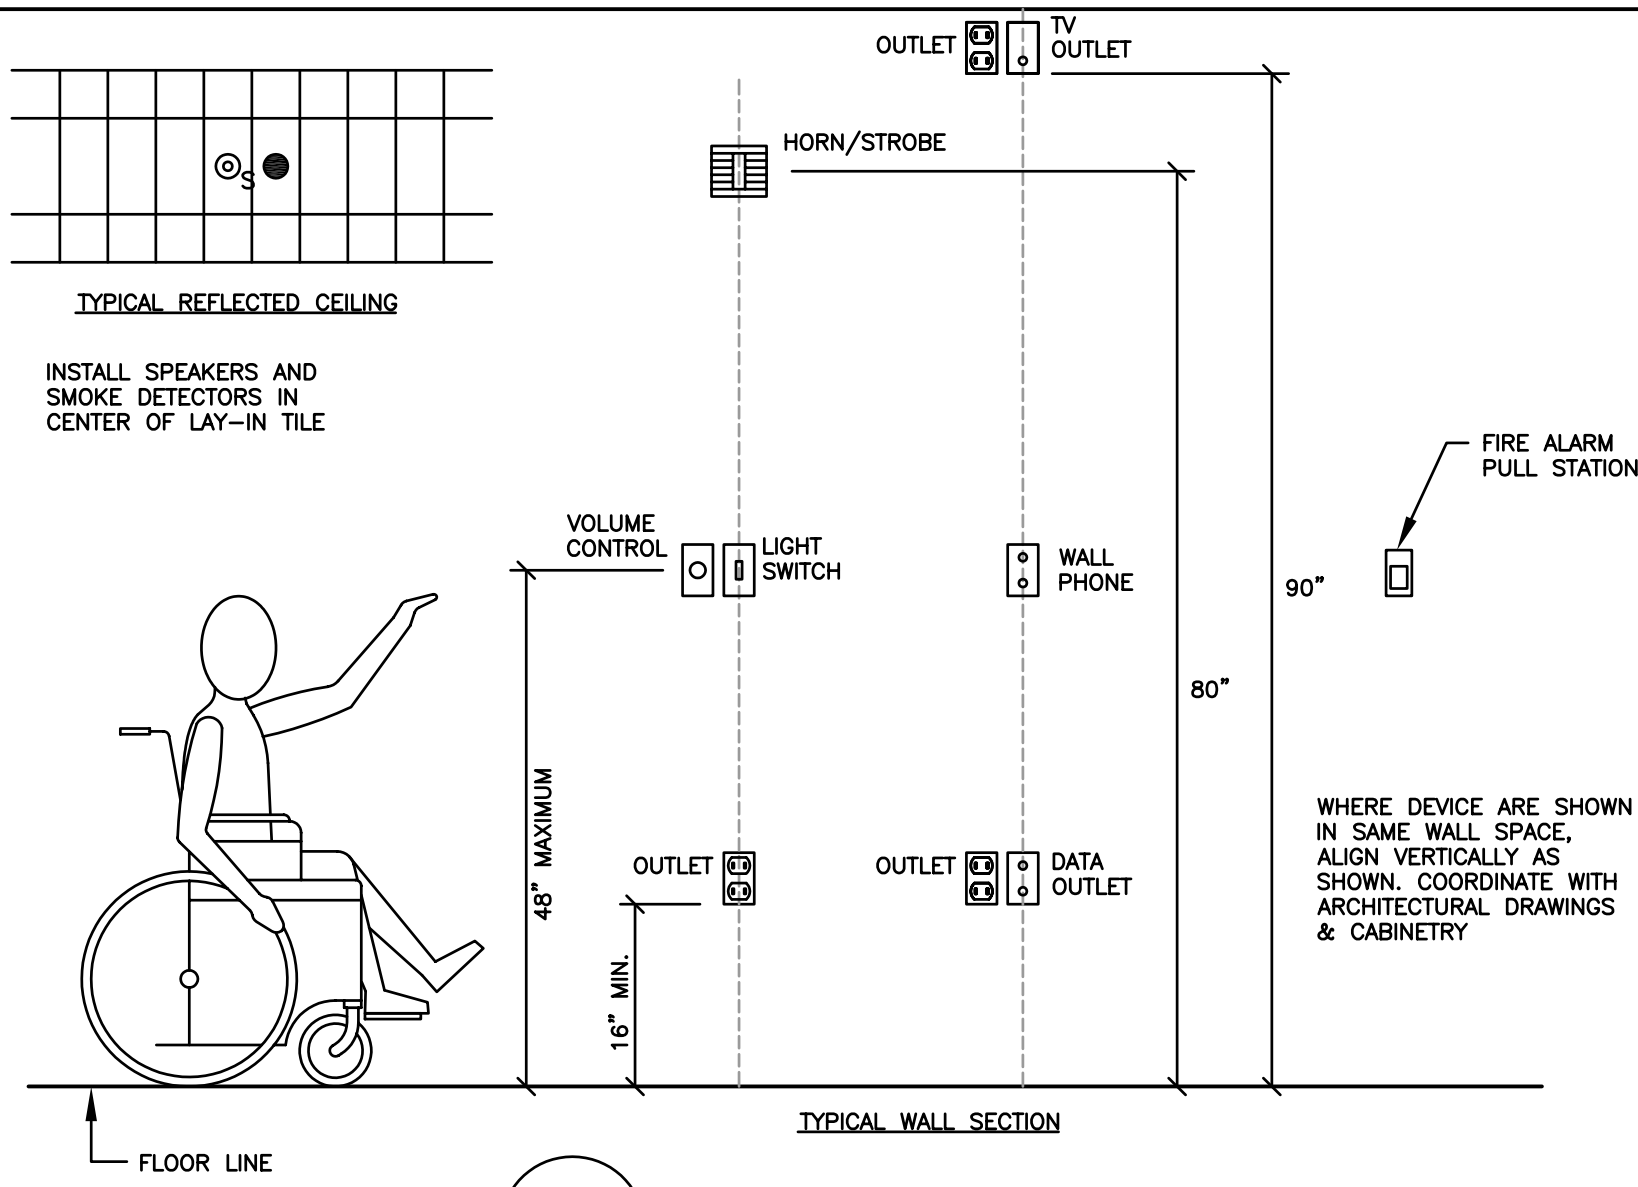


DIAGRAM R001 DEVICE MOUNTING HEIGHTS NTS

## PANELBOARD SCHEDULE


PANEL	K1	TYPE	EXISTING	120/208	VOLTS	3	PH	4	W						
MOUNTING	FLUSH	DIMENSIONS	W	LOCATION	STORAGE 120		X	LUGS							
	X SURFACE		D (in.)	AMP	225		MAINS	BREAKER							
			H					SUBFEED LUGS							
								ISO GROUND							
								200% NEUTRAL							
BRANCH BREAKERS															
ITEM	AMPS	POLE	WIRE SIZE	CIR. NO.	LEFT PHASE LOAD			RIGHT PHASE LOAD			CIR. NO.	AMPS	POLE	WIRE SIZE	ITEM
EXISTING LOAD	20	1	1	1	A	B	C	A	B	C	2	20	1	EXISTING LOAD	
EXISTING LOAD	20	1	3	3							4	20	1	EXISTING LOAD	
EXISTING LOAD	20	1	5	5							6	20	1	EXISTING LOAD	
EXISTING LOAD	20	1	7	7							8	20	1	EXISTING LOAD	
EXISTING LOAD	20	1	9	9							10	20	1	EXISTING LOAD	
EXISTING LOAD	20	1	11	11							12	20	1	EXISTING LOAD	
EXISTING LOAD	20	1	13	13							14	20	1	EXISTING LOAD	
EXISTING LOAD	20	1	15	15							16	20	1	EXISTING LOAD	
EXISTING LOAD	20	1	17	17							18	20	1	EXISTING LOAD	
EXISTING LOAD	20	1	19	19							20	20	1	EXISTING LOAD	
EXISTING LOAD	20	1	21	21							22	20	1	EXISTING LOAD	
SPACE ONLY			23	23							24			SPACE ONLY	
SPACE ONLY			25	25							26			SPACE ONLY	
SPACE ONLY			27	27							28			SPACE ONLY	
SPACE ONLY			29	29							30			SPACE ONLY	
SPACE ONLY			31	31							32			SPACE ONLY	
SPACE ONLY			33	33							34			SPACE ONLY	
SPACE ONLY			35	35							36			SPACE ONLY	
SPACE ONLY			37	37							38			SPACE ONLY	
PANEL SA	*	60	2	39							40			SPACE ONLY	
		60	2	41	1260						42			SPACE ONLY	
					0	1260	1260	0	0	0					
					0	1260	1260	TOTAL						CONNECTED LOAD TOTAL	
					0.00	10.50	10.50	AMPS/PHASE						2520 VA	
EQUIP RATING															
AMPS RMS SYM.															
* PROVIDE NEW BREAKER															

## PANELBOARD SCHEDULE

PANEL	SA	TYPE	NGQB	120/240	VOLTS	1	PH	3	W
MOUNTING	FLUSH	DIMENSIONS	20 W	LOCATION	STORAGE BLDG	MAINS	X	LUGS	BREAKER
	X SURFACE	6 D (in.)	H	AMP	60			SUBFEED LUGS	ISO GROUND
								200% NEUTRAL	
BRANCH BREAKERS									
ITEM	AMPS	POLE	WIRE SIZE	CIR. NO.	L. PHASE LOAD	R. PHASE LOAD	CIR. NO.	AMPS	POLE
LIGHTING	20	1	12	1	600		2	20	1
LIGHTING	20	1	12	3			4	20	1
LIGHTING	20	1	10	5	660		6	20	1
LIGHTING	20	1	10	7	600		8	20	1
SPACE ONLY			9	9			10		
SPACE ONLY			11	11			12		
SPACE ONLY			13	13			14		
SPACE ONLY			15	15			16		
SPACE ONLY			17	17			18		
SPACE ONLY			19	19			20		
SPACE ONLY			21	21			22		
			23	23			24		
			25	25			26		
			27	27			28		
			29	29			30		
			31	31			32		
			33	33			34		
			35	35			36		
			37	37			38		
			39	39			40		
			41	41			42		
					1260	1260	0	0	
					1260	1260	TOTAL		
					10.50	10.50	AMPS/PHASE		
					CONNECTED LOAD TOTAL				
					2520 W				
					EQUIP RATING				
					10,000 AMPS RMS SYM.				

## SHEET KEYNOTES

- 1 PROVIDE NEW BREAKER IN EXISTING PANEL 'K1' TO FEED NEW PANEL 'SA'.
- 2 PROVIDE (3) #2 THWN CU, (1) #6 THWN CU GND. IN A 1-1/2" CONDUIT.
- 3 PROVIDE (1) #8 THWN CU GROUND CONDUCTOR TO TWO GROUND RODS DRIVEN EXTERIOR TO BUILDING, TIE TO BUILDING STRUCTURAL STEEL AND TO UFER GROUND IN FOOTING PER SPECIFICATION.

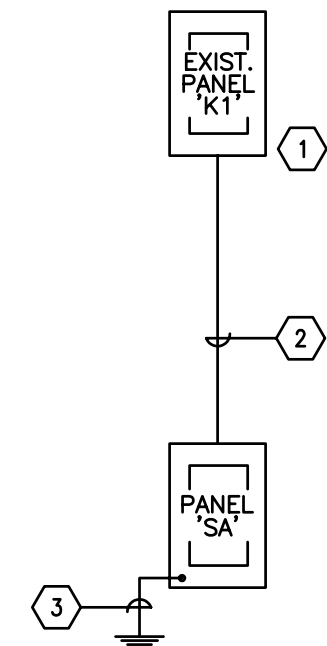

1 ONE-LINE DIAGRAM NO SCALE

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ONE LINE  
DIAGRAM &  
PANELBOARD  
SCHEDULE

**EX101**  
SHEET # OF #